# CIVIL ENGINEERING WORKS






	Sheet List Table
Sheet Number	Sheet Title
CD-000-001	COVER SHEET
CD-060-001	GENERAL ARRANGEMENT PLAN - SHEET 1 OF 2
CD-060-002	GENERAL ARRANGEMENT PLAN - SHEET 2 OF 2
CD-070-001	SEDIMENT & EROSION CONTROL PLAN - SHEET 1 OF 2
CD-070-002	SEDIMENT & EROSION CONTROL PLAN - SHEET 2 OF 2





LEND LEASE


WOOD & GRIEVE ENGINEERS


MORPETH AGED CARE

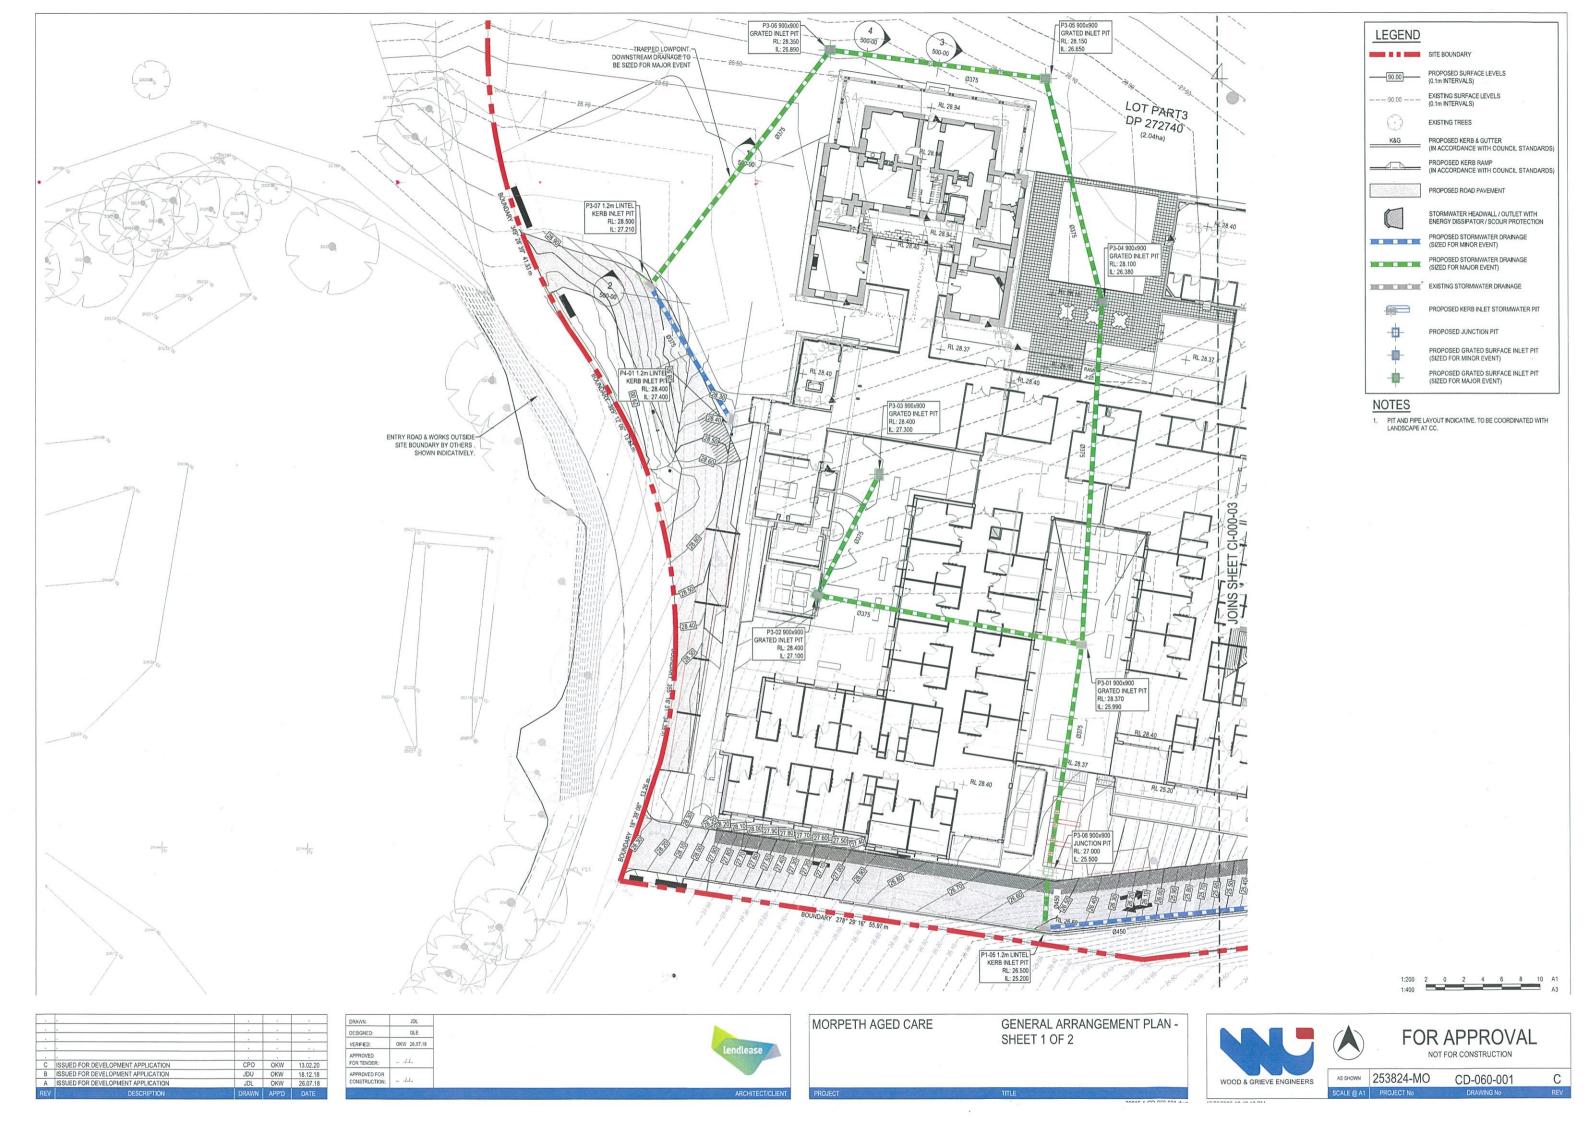

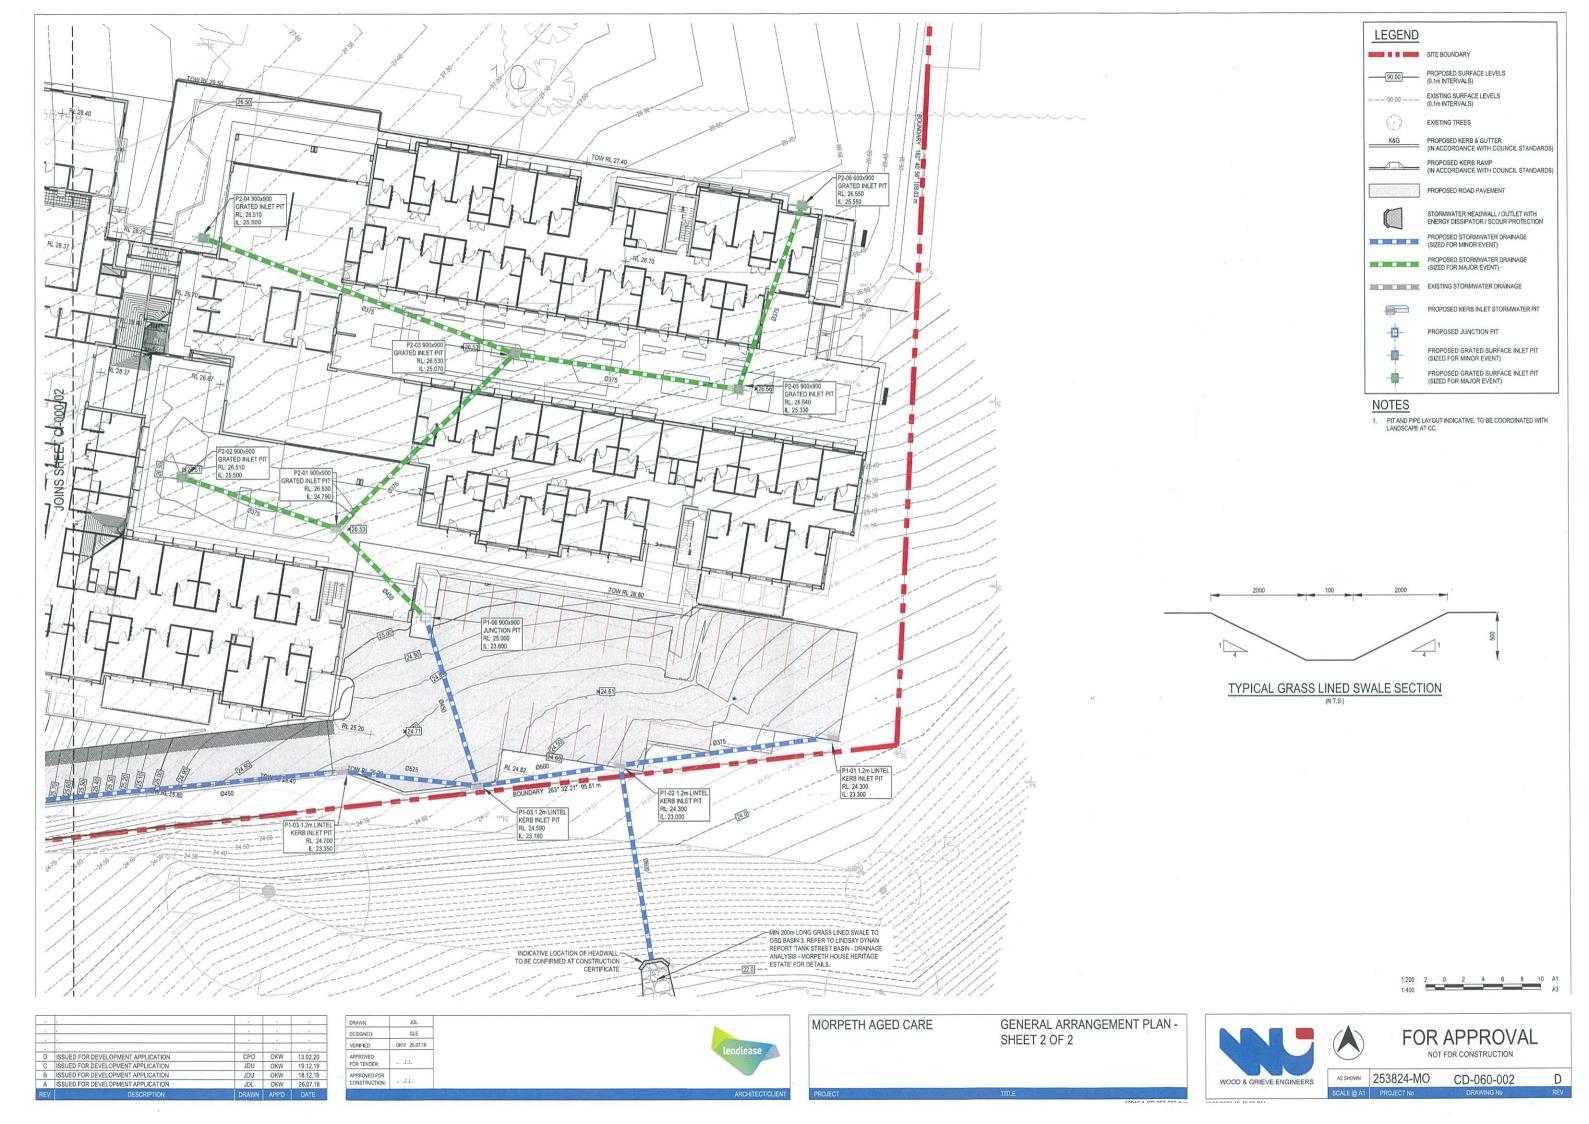

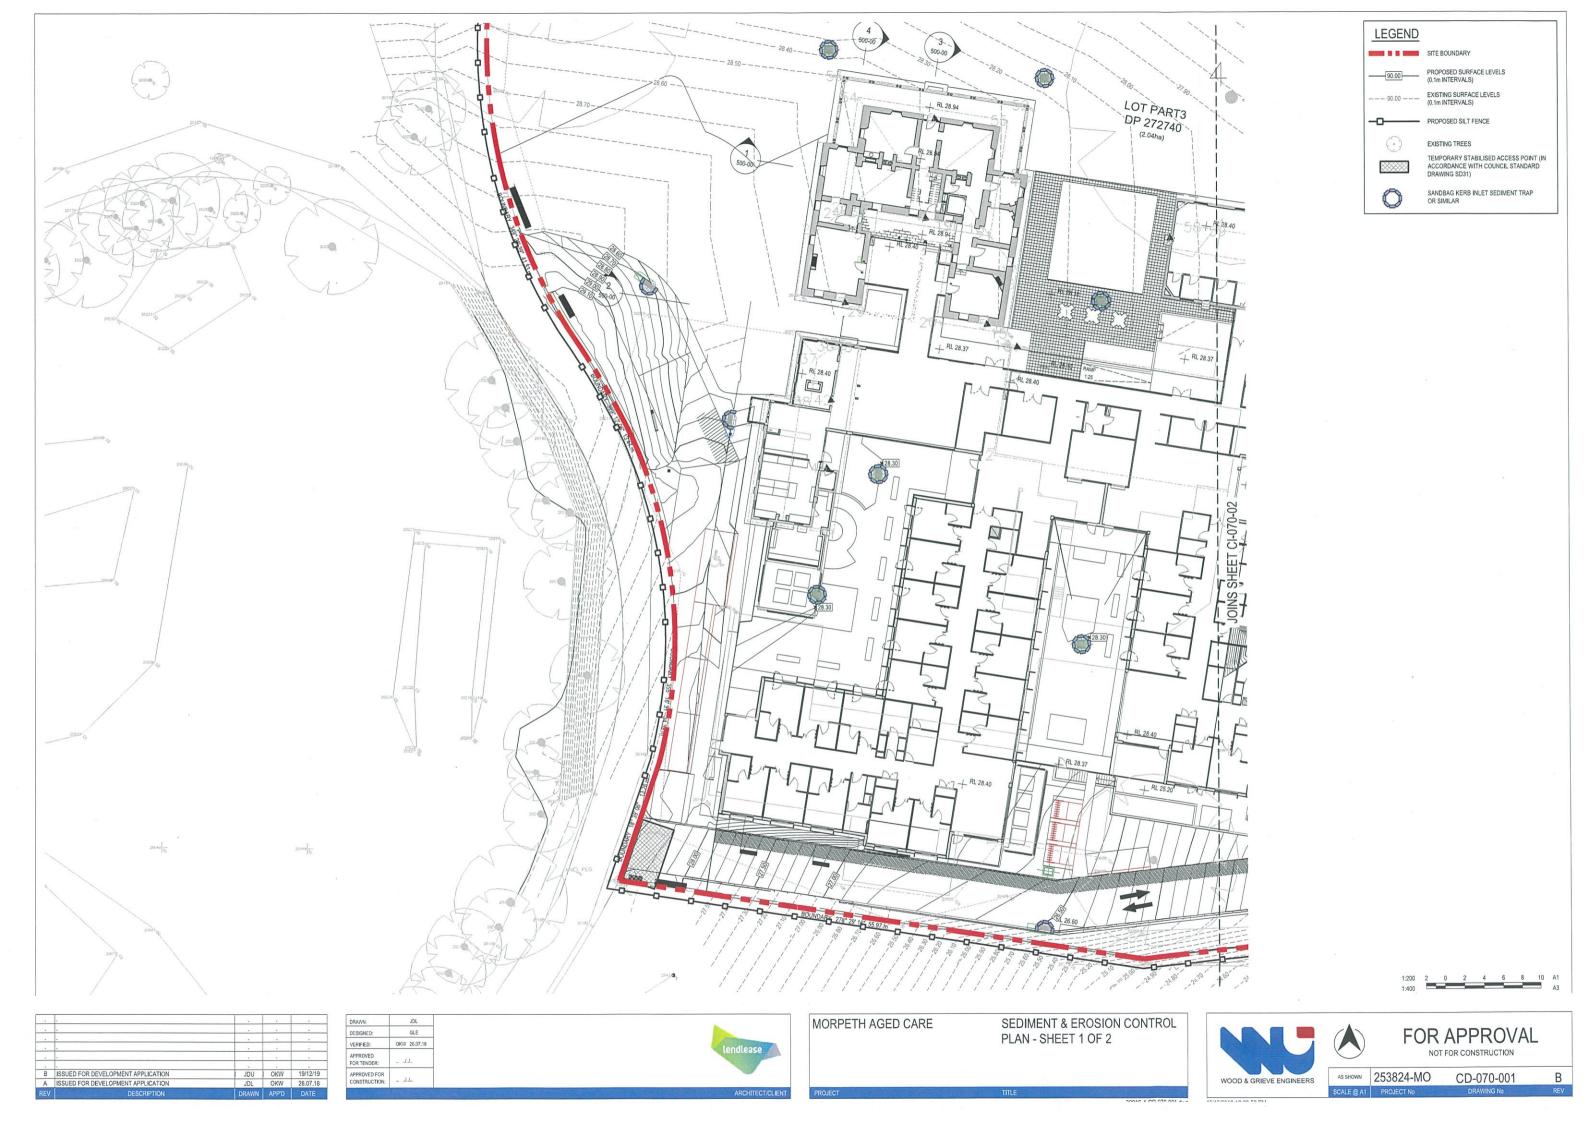

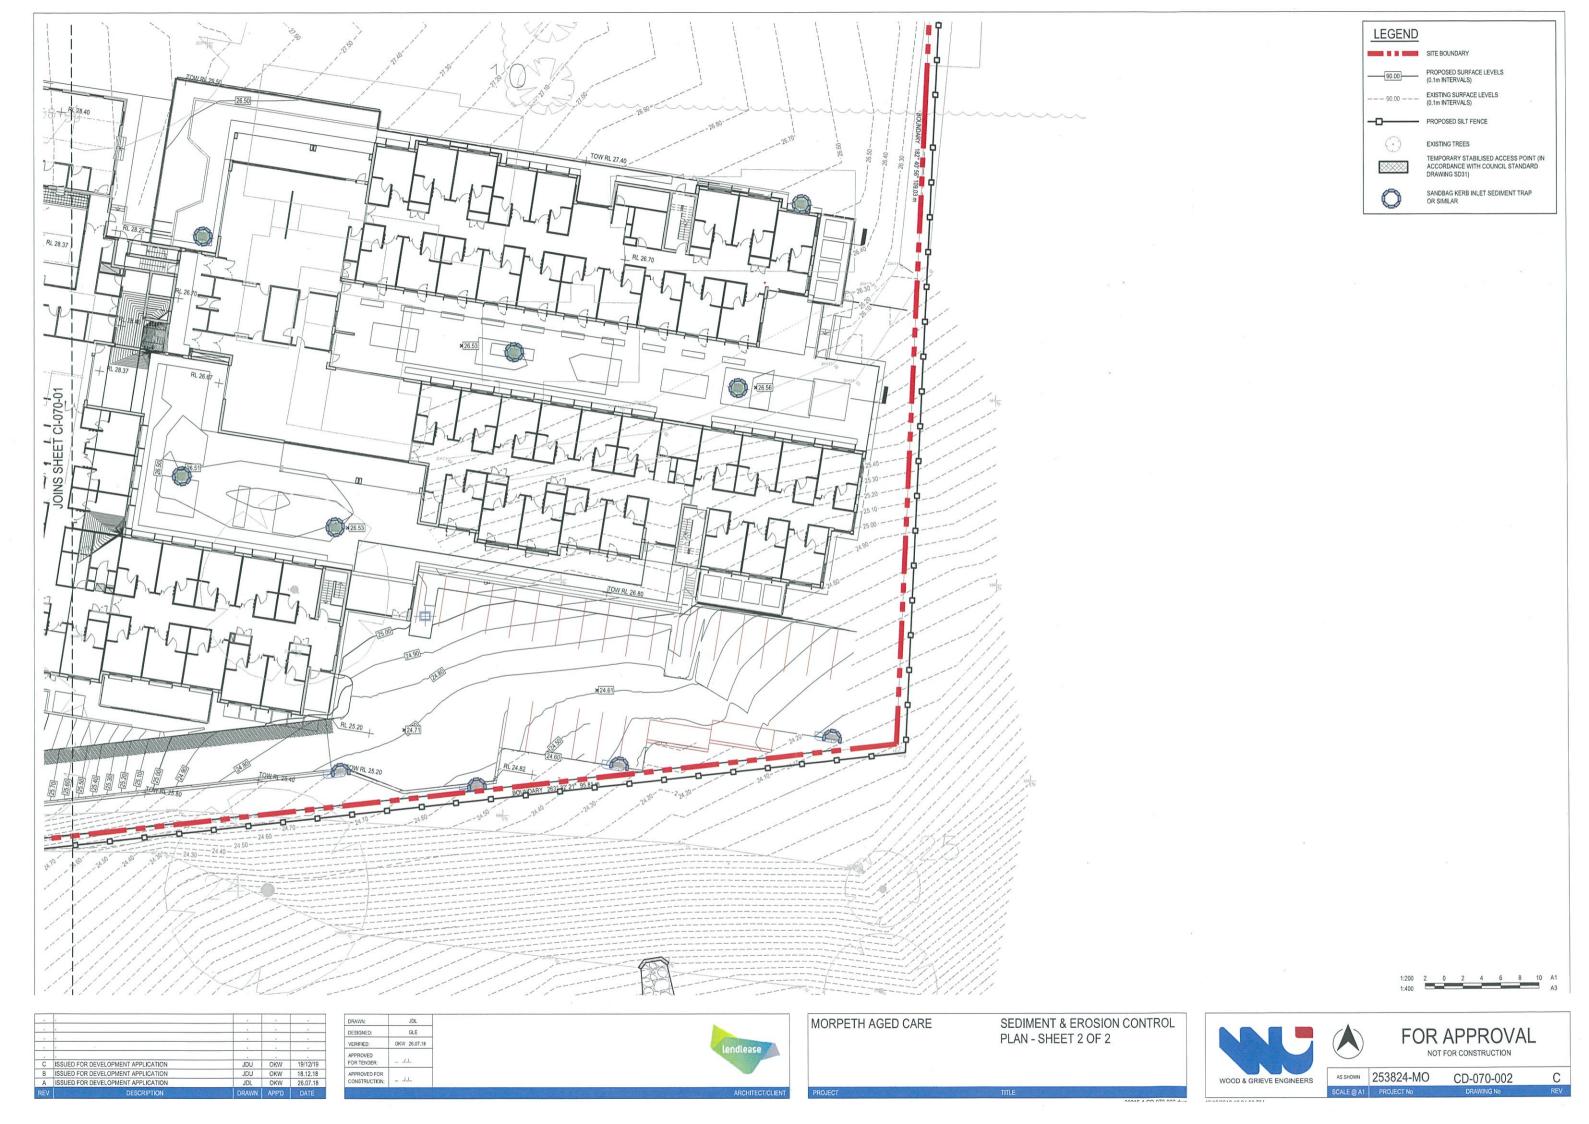

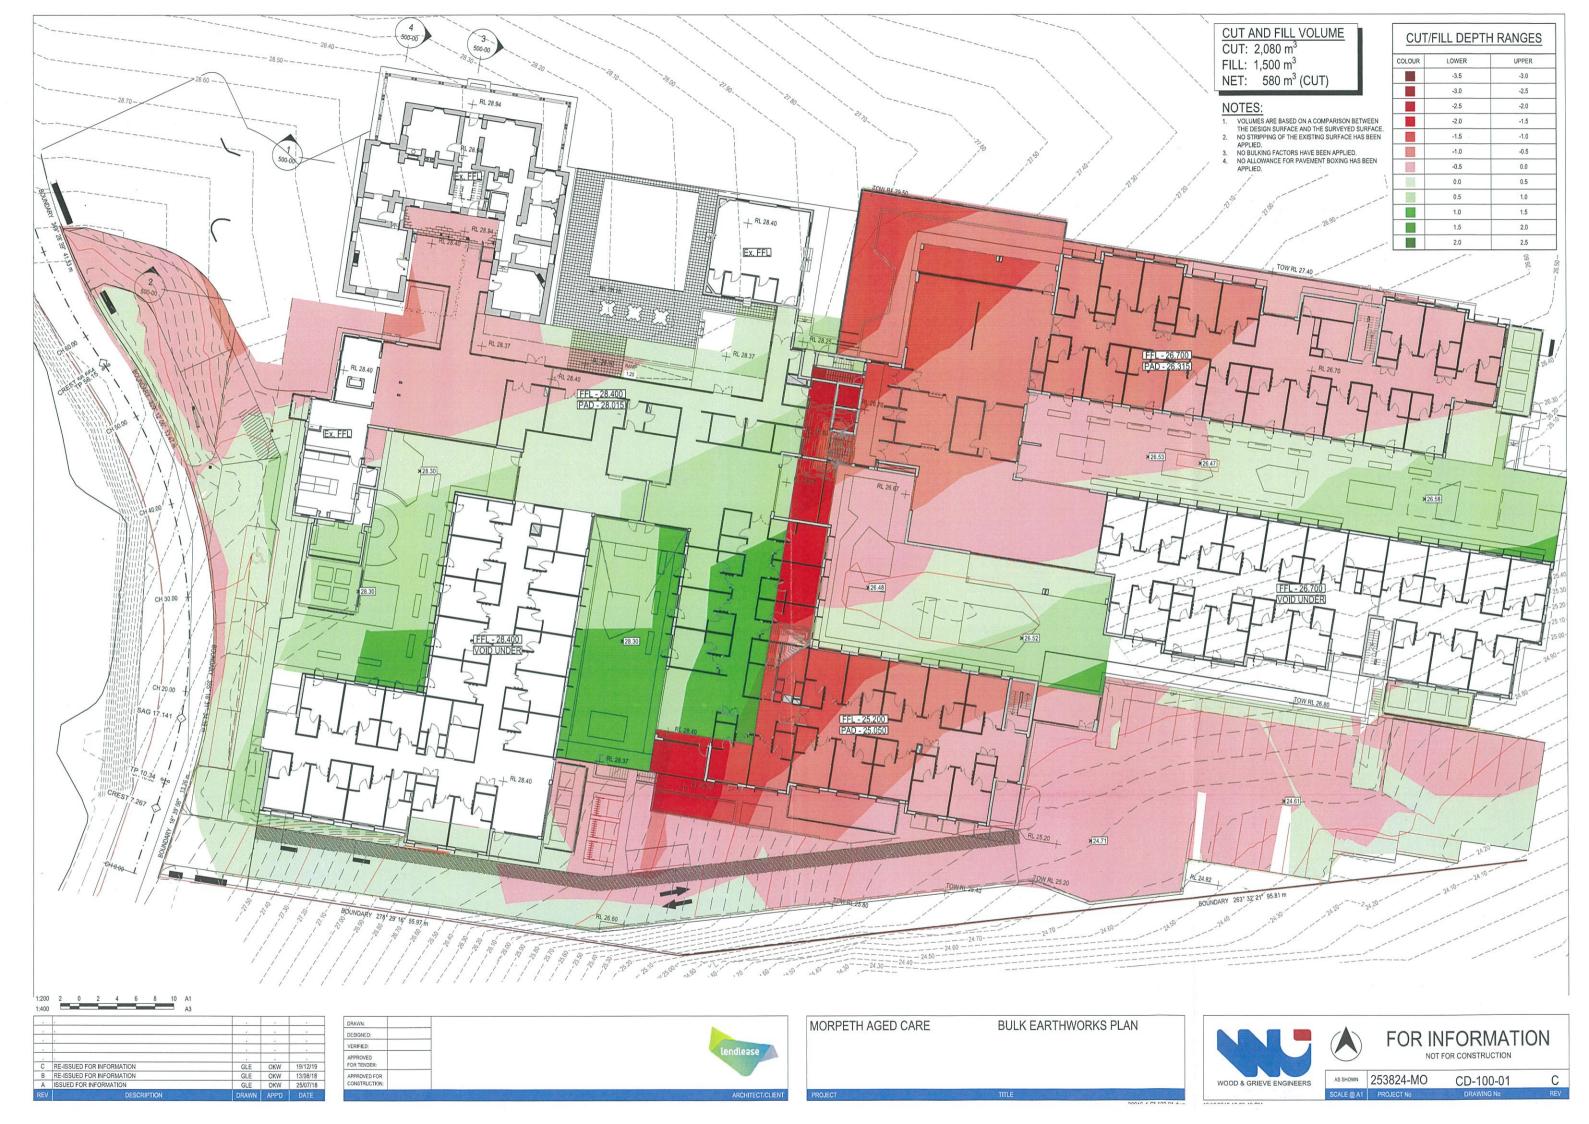





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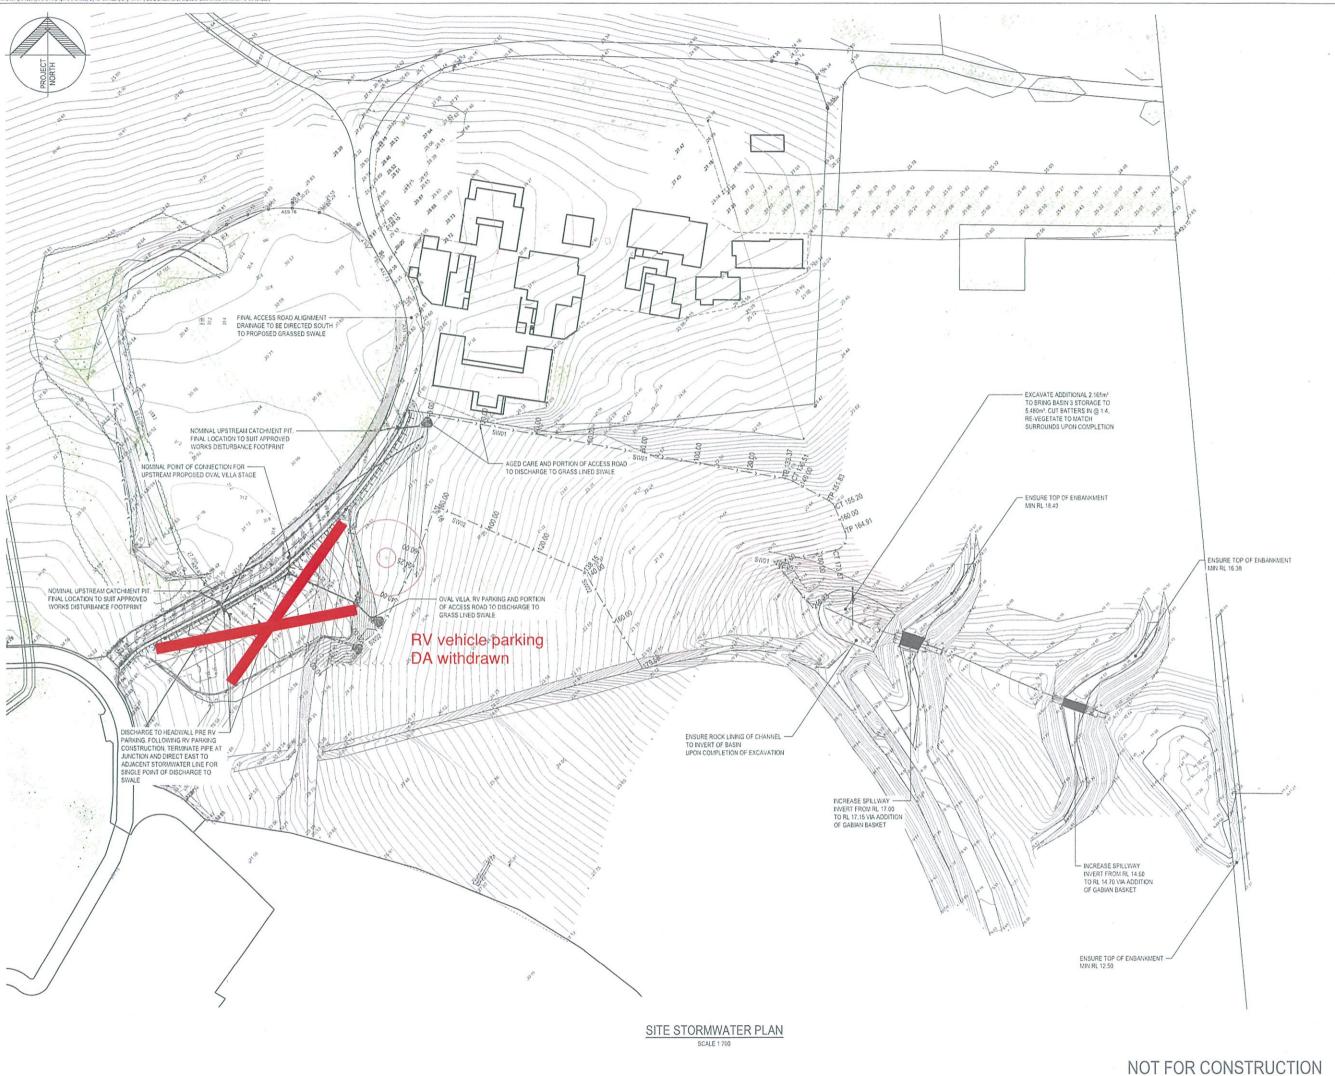
5 Newton Street Broadmeadow NSW 2292 T: +61 2 49419900 E: mail@lindsaydynan.com.au

MORPETH HOUSE HERITAGE ESTATE MORPETH ROAD, MORPETH NSW

LEND LEASE PRIMELIFE RETIREMENT VILLAGE (CLOSEBOURNE) PTY LTD

GENERAL ARRANGEMENT PLAN

DRAWING STATUS		A1	
FOR APPROVAL			
DRAWN	DESIGNED	APPROVED	SCALE
K. McNulty	C.Davies	C.Davies	1:700
		DRAWING No.	REVISION
PROJECT No.		Divillion	





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MORPETH HOUSE HERITAGE ESTATE MORPETH ROAD, MORPETH NSW

CLIENT

LEND LEASE PRIMELIFE RETIREMENT VILLAGE (CLOSEBOURNE) PTY LTD

#### LEGEND EXISTING CONTOUR EXISTING SPOTLEVEL --- 312 ----DESIGN CONTOUR NEW SEALED ACCESS ROAD 8 NEW STORMWATER DRAINAGE PIT NEW STORMWATER DRAINAGE PIPE HEADWALL NEW GRASS LINED SWALE. DENOTES DIVERISON DRAIN, REFER TO DRAWING DA-2205, DA-2207 FOR DETAILS BOUNDARY LINE EXISTING FENCE EXISTING TREE

## STORMWATER NOTES

THE PROPOSED WORKS CONSIST OF:

- CONSTRUCTION OF 14 VILLAS
- CONSTRUCTION OF ASSOCIATED ROAD, PARKING AND DRAINAGE WORKS
- INCLUSION OF SURROUNDING PATHWAYS AND LANDSCAPING

## STORMWATER QUALITY

STORMWATER QUALITY
A SITE WIDE CATCHMENT ANALYSIS WAS UNDERTAKEN TO DETERMINE
THE CATCHMENT EXTENT DIRECTED TO THE TANK STREET OSD BASIN.
THE RESULTANT WATER QUALITY INCLUSIONS FOR THIS SPECIFIC
DEVELOPMENT TO ACHIEVE THE COUNCIL DISCHARGE PARAMETERS
ARE AS FOLLOWS:

- EACH VILLA TO HAVE A 2,000L RE-USE TANK TO COLLECT ALL ROOF WATER FOR OUTDOOR IRRIGATION
- STORMWATER RUNOFF DIRECTED TO A 4 1m WIDE SWALE FOR WATER QUALITY TREATMENT PRIOR TO ENTERING THE TANK STREET BASINS.

A MUSIC MODEL WAS UNDERTAKEN TO CONFIRM THE WATER QUALITY TARGETS ARE ACHEVED WITH THE ABOVE MEASURES. FOR FURTHER DETAIL REGARDING THE PROPOSED WATER QUALITY MEASURES AND RESULTS. REPERT OTHE TAXAS STREET DRAINAGE ANALYSIS REPORT PREPARED BY LINDSAY DYNAN.

#### STORMWATER DETENTION

SMILLAR TO THE WATER QUALITY ANALYSIS. DETENTION RATES WERE ALSO MODELLED BASED ON VARIOUS IMPERVIOUS FRACTIONS ACROSS THE SITE. THESE WORKS ARE DETAILED IN THE TANK STREET DRAMAGE ANALYSIS REPORT.

TO ALLOW THE OVAL VILLA WORKS, THE TANK STREET BASIN WORKS ARE ANTICIPATED TO INCLUDE:


- · RAISING THE BASE OF THE FIRST WEIR TO INCREASE INITIAL
- EXCAVATION WITHIN THE FIRST BASIN TO INCREASE STORAGE

THE ABOVE WORKS ARE ANTICIPATED TO RETAIN PRE-DEVELOPMENT DISCHARGE RATES FOLLOWING THE PROPOSED DEVELOPMENT.

A 05/02/20
REV DATE DRAWING STATUS


## SITE STORMWATER PLAN

DRAWING STATU	13		SHEET SIZE
FOR APPROVAL			A1
DRAWN	DESIGNED	APPROVED	SCALE
K.McNulty	C.Davies	C.Davies	1:700
PROJECT No.		DRAWING No.	REVISION
1000	7 0	1 0001	Λ

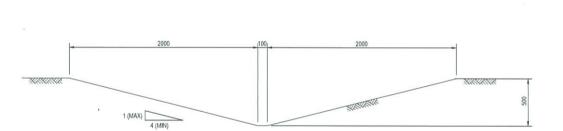

# 4.1m WIDE GRASS LINED STORMWATER DRAINAGE SWALE (SW01)

SCALE 1:20

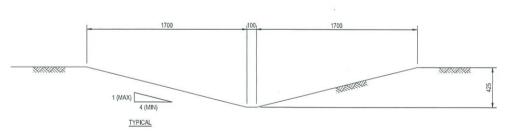

## 3.5m WIDE GRASS LINED STORMWATER DRAINAGE SWALE (SW02)

SCALE 1:20

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PROJECT

MORPETH HOUSE HERITAGE ESTATE MORPETH ROAD, MORPETH NSW

CLIENT

LEND LEASE PRIMELIFE RETIREMENT VILLAGE (CLOSEBOURNE) PTY LTD

#### STORMWATER NOTES

THE PROPOSED WORKS CONSIST OF:

- CONSTRUCTION OF 14 VILLAS
- CONSTRUCTION OF ASSOCIATED ROAD, PARKING AND DRAINAGE WORKS
- INCLUSION OF SURROUNDING PATHWAYS AND LANDSCAPING

#### STORMWATER QUALITY

A SITE WIDE CATCHMENT ANALYSIS WAS UNDERTAKEN TO DETERMINE THE CATCHMENT EXTENT DIRECTED TO THE TANK STREET OSD BASIN. THE RESULTANT WATER QUALITY INCLUSIONS FOR THIS SPECIFIC DEVELOPMENT TO ACHIEVE THE COUNCIL DISCHARGE PARAMETERS ARE AS FOLLOWS:

- FOLLOWS:
   EACH VILLA TO HAVE A 2,000L RE-USE TANK TO COLLECT ALL ROOF WATER FOR OUTDOOR IRRIGATION
   STORMWATER RUNOFF DIRECTED TO A 4.1m WIDE SWALE FOR WATER QUALITY TREATMENT PRIOR TO ENTERING THE TANK STREET BASINS.

A MUSIC MODEL WAS UNDERTAKEN TO CONFIRM THE WATER QUALITY TARGETS ARE ACHIEVED WITH THE ABOVE MEASURES, FOR FURTHER DETAIL REGARDING THE PROPOSED WATER QUALITY MEASURES AND RESULTS, REFER TO THE TANKS STREET DRAINAGE ANALYSIS REPORT-PREPARED BY LINDSAY DYNAN.

### STORMWATER DETENTION

SIMILAR TO THE WATER QUALITY ANALYSIS, DETENTION RATES WERE ALSO MODELLED BASED ON VARIOUS IMPERVIOUS FRACTIONS ACROSS THE SITE. THESE WORKS ARE DETAILED IN THE TANK STREET DRAINAGE ANALYSIS REPORT.


TO ALLOW THE OVAL VILLA WORKS, THE TANK STREET BASIN WORKS ARE ANTICIPATED TO INCLUDE:


- RAISING THE BASE OF THE FIRST WEIR TO INCREASE INITIAL WATER HOLDING CAPACITY
- EXCAVATION WITHIN THE FIRST BASIN TO INCREASE STORAGE CAPACITY

THE ABOVE WORKS ARE ANTICIPATED TO RETAIN PRE-DEVELOPMENT DISCHARGE RATES FOLLOWING THE PROPOSED DEVELOPMENT.

### STORMWATER DETAILS

DRAWING STATUS		SHEET SIZE	
FOR APPROVAL			A1
DRAWN .	DESIGNED	APPROVED	SCALE
K.McNulty	C.Davies	C.Davies	1:700
PROJECT No.		DRAWING No.	REVISION
1000	7 0	A 000F	Α.

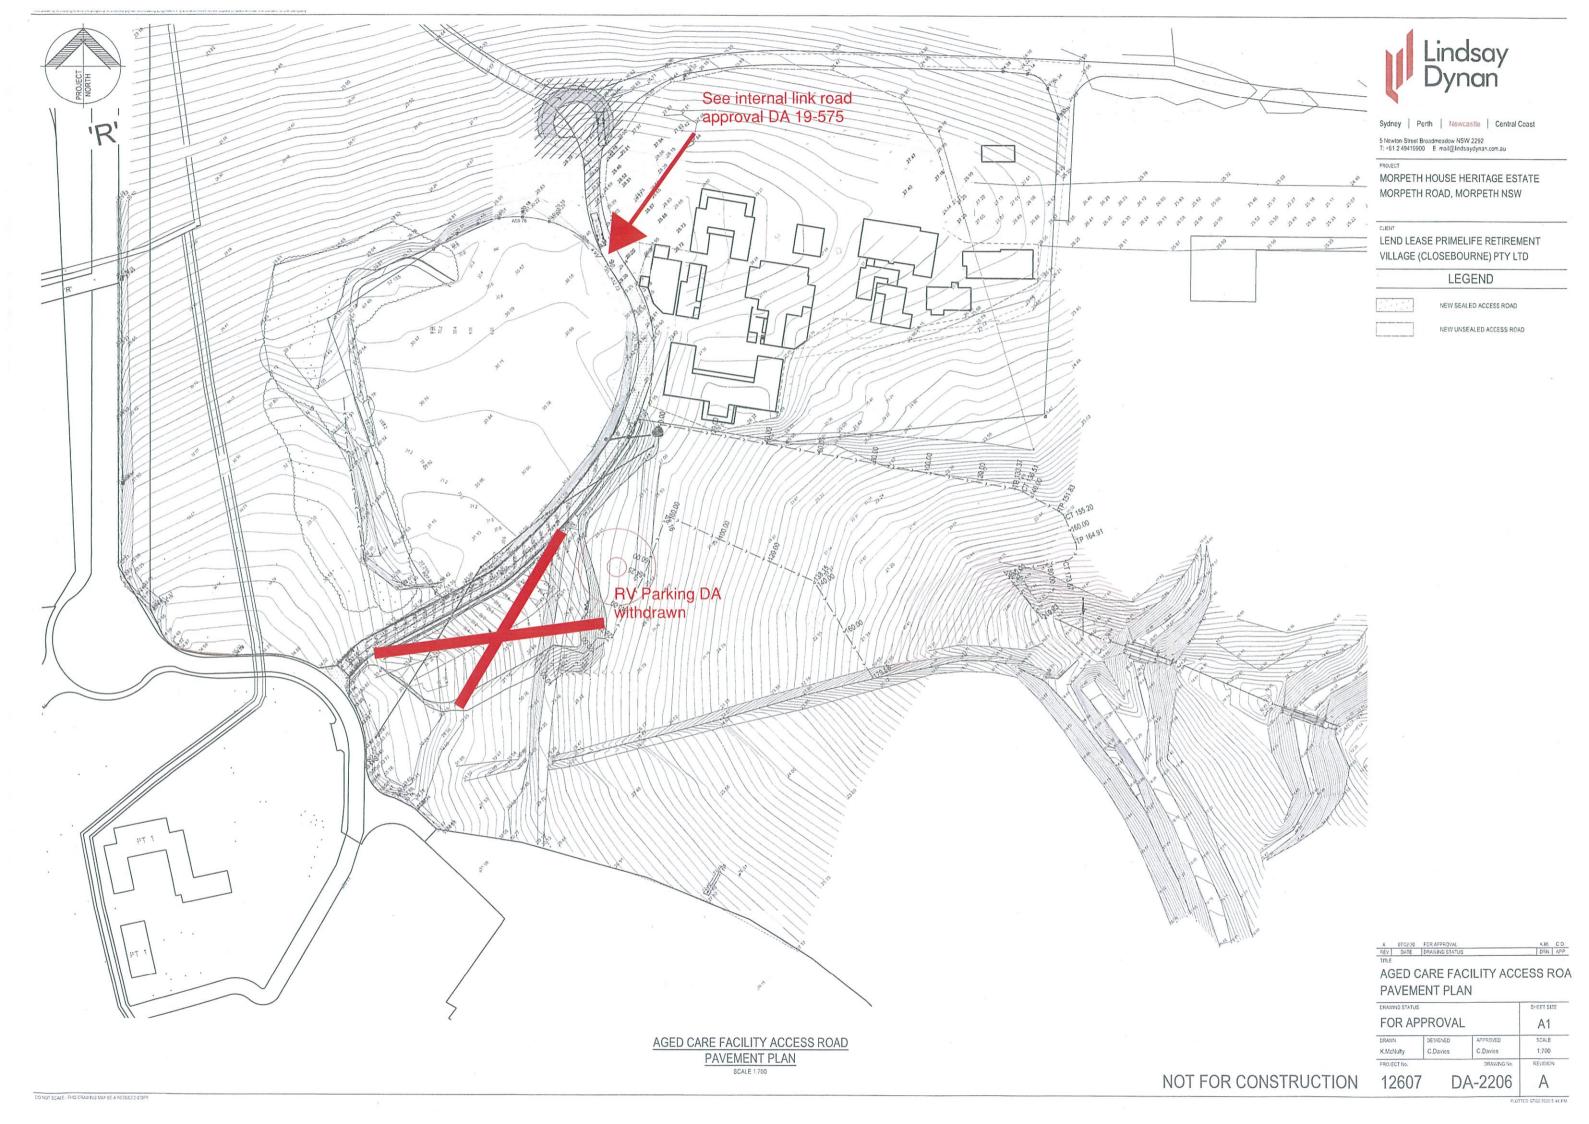

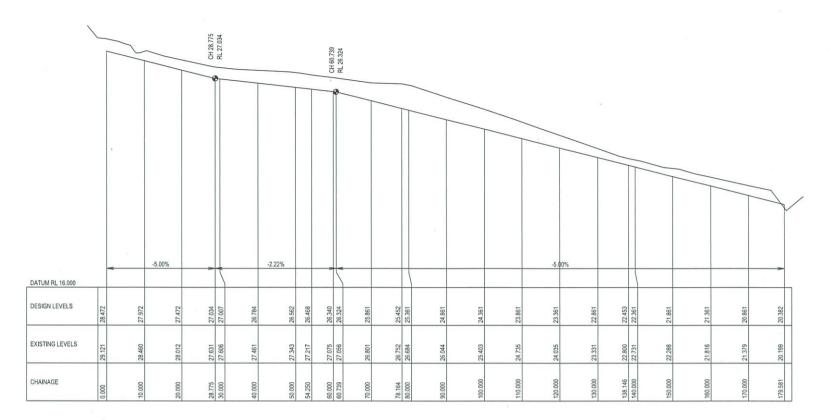

# LONGITUDINAL SECTION ALONG CONTROL SW02



# LONGITUDINAL SECTION ALONG CONTROL SW01



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PROJECT

MORPETH HOUSE HERITAGE ESTATE MORPETH ROAD, MORPETH NSW

LEND LEASE PRIMELIFE RETIREMENT VILLAGE (CLOSEBOURNE) PTY LTD

## **LEGEND**

21.50	EXISTING CONTOUR
44	EXISTING SPOTLEVEL
31.2 ·	DESIGN CONTOUR
	NEW SEALED ACCESS ROAD
∅	NEW STORMWATER DRAINAGE PIT
	NEW STORMWATER DRAINAGE PIPE
	HEADWALL
->	NEW GRASS LINED SWALE
	BOUNDARY LINE
	EXISTING FENCE
⊗	EXISTING TREE

#### STORMWATER NOTES

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STREET BASINS.

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TO ALLOW THE OVAL VILLA WORKS, THE TANK STREET BASIN WORKS ARE ANTICIPATED TO INCLUDE:

- RAISING THE BASE OF THE FIRST WEIR TO INCREASE INITIAL WATER HOLDING CAPACITY
- EXCAVATION WITHIN THE FIRST BASIN TO INCREASE STORAGE CAPACITY

THE ABOVE WORKS ARE ANTICIPATED TO RETAIN PRE-DEVELOPMENT DISCHARGE RATES FOLLOWING THE PROPOSED DEVELOPMENT.

# CONTROL SWALES LONGITUDINAL SECTIONS

DRAWING STATUS		SHEET SIZE	
FOR APPROVAL			
DRAWN	DESIGNED	APPROVED	SCALE
K.McNulty	C.Davies	C.Davies	1:500
PROJECT No. DRAWING No.		REVISION	
1260	7 D	A-2207	Δ

NOT FOR CONSTRUCTION

12607 DA-2207